

Individual Permit Application

For a Lake Encroachment Permit under

Chapter 11 of Title 29, § 401 et seq.

RECEIVED
JUL 1 2 2016
WS MD

Application Number: 2137-LP				
Submission of this application constitutes notice that the person of a lake or pond, and certifies that the project will comply with this form must be provided, and the requisite fees (Section I) mediated complete.	Chapter 11 of Title 29, § 401	et seq. All information required on		
A. Project Information				
1. Physical Address (911 Address): 982 West Lakeshore	Drive			
2a. Town- County: Colchester - Chittenden	•	2b. Zip: 05446		
3: Span (School-Parcel-Account Number is required for your application to be deemed complete. It can be obtained from your : property tax bill. If you cannot locate your property tax bill, please obtain this information from your Town Clerk)		1		
4. Name of Lake/Pond: Champlain Lake (Mallets Bay) - Colchester				
5. Have you ever applied for a permit with the Department of Environmental Conservation associated with this parcel? Yes No				
B. Applicant (Landowner if applicable) Contact Information				
1. Name: Champlain Marina, Inc				
2a. Mailing Address: P.O. Box 168				
2b. Town:Colchester	2c. State: Vt	2d. Zip:05446		
3. Phone: 802-658-4034	4. Email:bruce@champ	olainmarina.com		
C. Application Preparer Contact Information:				
1. Name:Bruce Deming				
2a. Mailing Address: P.O. Box 168				
2b. Town:Colchester	2c. State:Vt	2d. Zip:05446		
3. Phone:802-658-4034	4. Email:bruce@champlai	nmarina.com		
D. Abutting Land Owners				
Using the abutter addendum available on <u>.dec.vermont.gov.</u> , attach a list of land owners who abut the proposed project.				
E. Project Description				
1. Describe the proposed project including the description of used during construction and the anticipated work schedule or removal of fill and if so, specify the number of cubic yard beyond the shoreline at mean water level. Excavation of lake bottom to remove medium dens launching pier, service dock and entrance to service 2200 square feet of area. De- watering of the dred with in an area enclosed by a geotextile filter curtain at an upland, non-wetland site. Approx 400 cubic	e. Identify whether or not to sof fill or dredged material se gray silt and fine sar se dock. The dredging vill be vinn. Dredged material sh	the project includes placement als to be placed or removed and in area of existing will involve approximately a discharge into the lake all be disposed of properly		
The project description of initially dewatering dredged material within the geotextile filter curtain mirrors standard language used by VT Fish and Wildlife Department				

mbs 9/14/16.

Dredged material will be loaded onto dumptruck for transport to an upland site.

2. Describe the purpose of the proposed project: The existing facility has been in operation for 40 years. Gradual silting of the area has made it difficult, unsafe or impossible to service (hauling, fuel, pumpout,) boats at a water level of <95 asl. At this water level some sailboats boats ground out before getting to the service dock or hauling pier. Some larger power boats churn up sediment entering and exiting the service area.
3. Describe what less intrusive feasible alternatives have been considered: No less intrusive or feasible is available. Use of the geotextile sediment curtain will contain any tubidity within the dredging area.
Dredged material will be loaded onto dumptruck for transport to an upland site. mbs 9/14/16
4. Describe the public benefits of the proposed project: After the dredging the public will be able to safely utilize the services of Champlain Marina. Currently boats attemting to traverse the area are creating turbibity which is not contained.
Dredging will reduce turbidity currently occurring from boat propeller wash stirring up shallow bottom sediments. mbs 9/14/16
F. Encroachment Effects (describe how the proposed project will affect the following)
1. What measures are proposed to minimize the project's effects on water quality (e.g., use of a turbidity curtain)? The geotextile curtain will be installed around the project area. It will remain in place untill the turbidity has subsided. Oil absorbing boom will be floated in the area to absorb and contain any petroleum product that may find it's way into the water (excavator lubricant etc.)
2. How will the project minimize effects to fish and wildlife habitat (e.g., project is not to commence until after fish spawning July 1 of any calendar year)? The excavation will take place in an area of high activity (boat movement) It is unlikely this will negatively impact any habitat.

3. Does the project propose removal of aquatic or shoreline vegetation? If so, what measures are proposed to reduce
the effects of vegetation removal? All work will be done below OLW. No vegetation, or shoreline will be impacted.
All work will be done below OEW. No vegetation, or shoreline will be impacted.
4. Describe the surrounding shoreline. Is the project consistent with these surroundings? What measures are
proposed to ensure the project is in-keeping with the surroundings?
This project involves the removal of material below OLW. It will not be visable to , and will not
change the surrounding area. Dredging is a common maintenace issue for maintaining facility
operations as well as improving navigation on public waters.
5. Will the project affect navigation, recreation, and other public uses? If so, how will these effects be minimized?
The proposed dreding will be done during the week in late summer. Arrangements will be made for limited fueling, and we have portable back up sewage pump out equipment to continue that service.
After work is completed, boaters will have safer and more efficient access to necessary services
The work to completed, seatore will have early and more emolent access to heccessary convicts
G. Applicant Certification
As APPLICANT, I hereby certify that the statements presented on this application are true and accurate and recognize that by signing this application, I agree to complete all aspects of the project as authorized. I understand that failure
to comply with the foregoing may result in violation of the Chapter 11 of Title 29, § 401 et seq., and the Vermont
Agency of Natural Resources may bring an enforcement action for violations of the Act pursuant to 10 V.S.A. chapter
201.
Q D:
Applicant (landowner if applicable) Signature: Market Date: 103 4 2016
I. Applicant Preparer Certification (if applicable)
As APPLICATION PREPARER, I hereby certify under penalty of law that this document and all attachments were
prepared under my direction or supervision in accordance with a system designed to assure that qualified personnel
properly gathered and evaluated the information submitted. Based on my inquiry of the person or persons who
manage the system, or those persons directly responsible for gathering the information, the information submitted is,
to the best of my knowledge and belief, true, accurate, and complete. I am aware that there are significant penalties for submitting false information, including the possibility of fine and imprisonment for knowing violations.
for submitting raise information, including the possibility of the and imprisonment for knowing violations.
Application Preparer Signature: Date:
0
J. Additional Required Documentation: (please check to ensure you have completed the following)
All sections of the application are complete or otherwise indicate "not applicable";
Application includes site plans with aerial and cross section views;
Application includes site plans with aerial and cross section views; Application description includes dimensions and surface areas of cleared areas and impervious surfaces; and

K. Permit Application Fees		
Select the most applicable permit description project types, multiple fees may apply. For eximprovement will require both fees (2) and (3)	cample, a project involving structural er 3).	
1. Non-structural erosion control project (e.		
Non-structural erosion control project: \$155.	00	
Total:		
2. Structural erosion control project		
Structural erosion control project: \$250.00		1
Total:		
3. Other Projects (e.g., marina improvement	s):	
Other Project: \$300.00		300
Project Cost Fee: 0.01 times project cost	Total Project Cost: <u>/ 6,000</u> x 0.01	100
Total:		\$-0.00 400.00

Submit this form and application fee, payable to:
State of Vermont
Vermont Department of Environmental Conservation
Watershed Management Division
1 National Life Dr, Main 2
Montpelier, VT 05620-3522

Direct all correspondence or questions to Lake Encroachment Permitting at: <u>ANR.WSMDShoreland@vermont.gov.</u>

For additional information visit: http://dec.vermont.gov/watershed/lakes-ponds.



Lake Encroachment Application Addendum

For a Lake Encroachment Permit

Chapter 11 of Title 29, § 401 et seq.

This Abutting Land Owner Addendum is intended to accompany a completed <i>Lake Encroachment Permit Application</i> in instances of a proposed lake encroachment abutting land owners other than the applicant.
I. Abutting Land Owner Information
1. Name:Pier 10
Address: P.O. Box 156 Colchester, Vermont 05446
2. Name:Rozzi's Lakeshore Tavern
Address: 1022 West Lakeshore Dr. Colchester, Vermont 05446
3. Name:State of Vermont ANR
Address: One National Life Drive Montpelier, Vermont 05620
4. Name:
Address:
5. Name:
Address:
6. Name:
Address:
7. Name:
Address:
8. Name:
Address:
9. Name:
Address:
10. Name:
Address:


Submit this form as an addendum to a complete Lake Encroachment Application to:

State of Vermont
Vermont Department of Environmental Conservation
Watershed Management Division
Lake Encroachment Permitting 1
National Life Drive, Main 2
Montpelier, VT 05620-3522

Direct all correspondence or questions to Lake Encroachment Permitting at:

ANR.WSMDShoreland@vermont.gov

For additional information visit: http://dec.vermont.gov/watershed

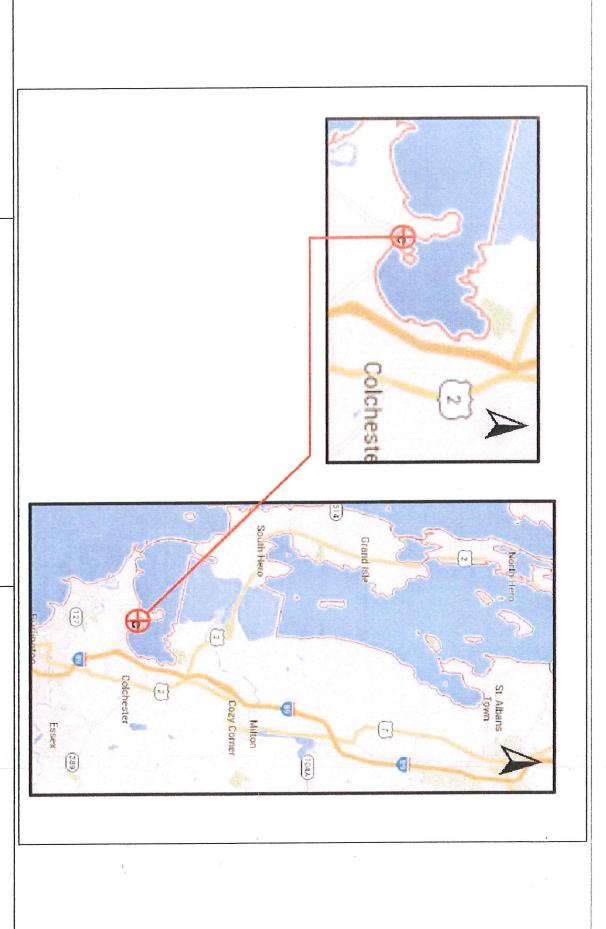


DRAWN: A. SPENCER REVISED: B. DEMING SCALE: AS NOTED DATE: 07/01/2016 DESIGNED: B. DEMING

> 982 W. LAKESHORE DRIVE CHAMPLAIN MARINA, INC.

STATE: VERMONT ZIP: 05446 TOWN: COLCHESTER

PROJECT: MAINTENANCE DREDGING OF EXISTING SERVICE AREA



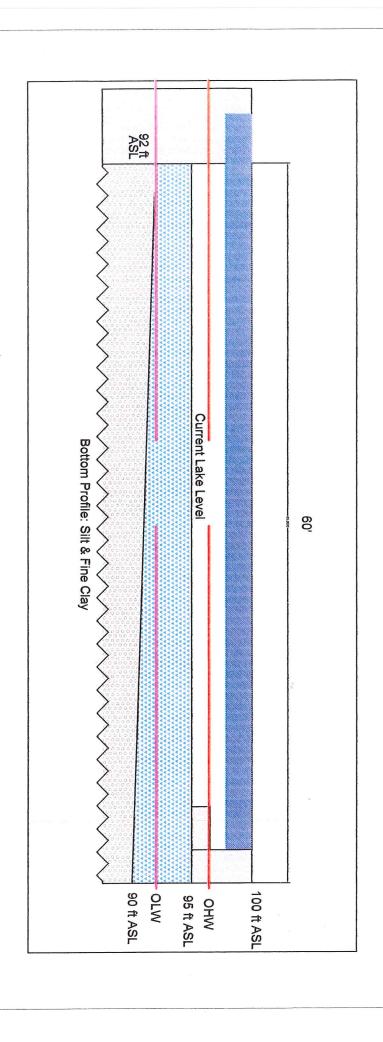

DESIGNED: B. DEMING DRAWN: A. SPENCER REVISED: B. DEMING DATE: 07/01/2016

SCALE: AS NOTED


982 W. LAKESHORE DRIVE

TOWN: COLCHESTER STATE: VERMONT


1.5" =

ZIP: 05446

PROJECT: MAINTENANCE DREDGING OF EXISTING SERVICE AREA

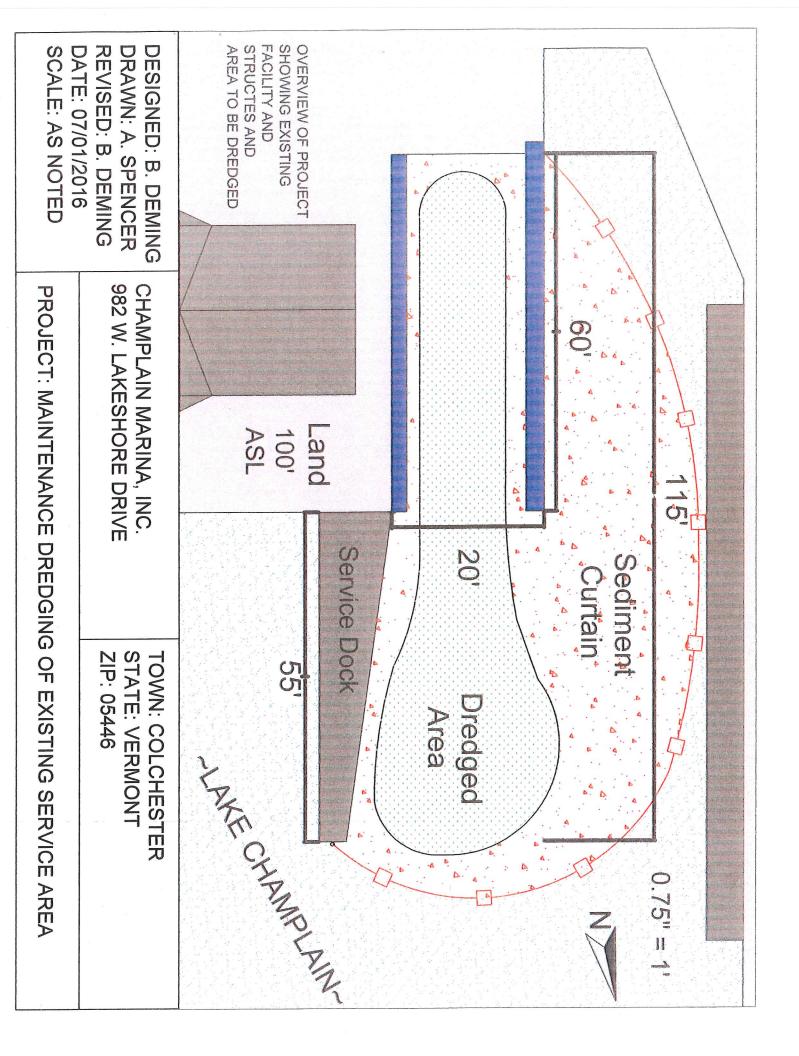

ABUTTING PROPERTIES

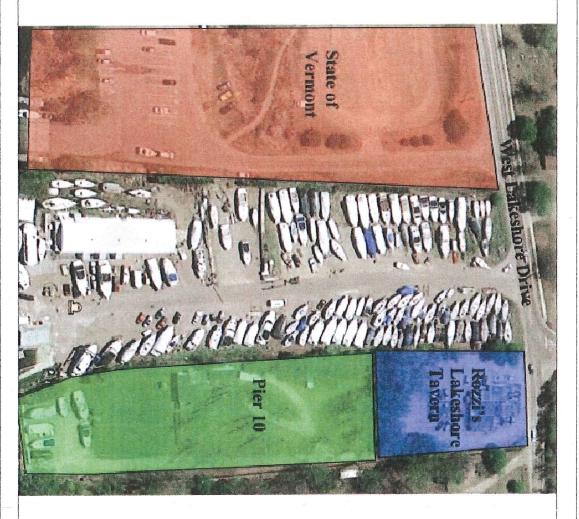


DESIGNED: B. DEMING DRAWN: A. SPENCER REVISED: B. DEMING DATE: 07/01/2016

SCALE: AS NOTED

982 W. LAKESHORE DRIVE

TOWN: COLCHESTER STATE: VERMONT ZIP: 05446

PROJECT: MAINTENANCE DREDGING OF EXISTING SERVICE AREA

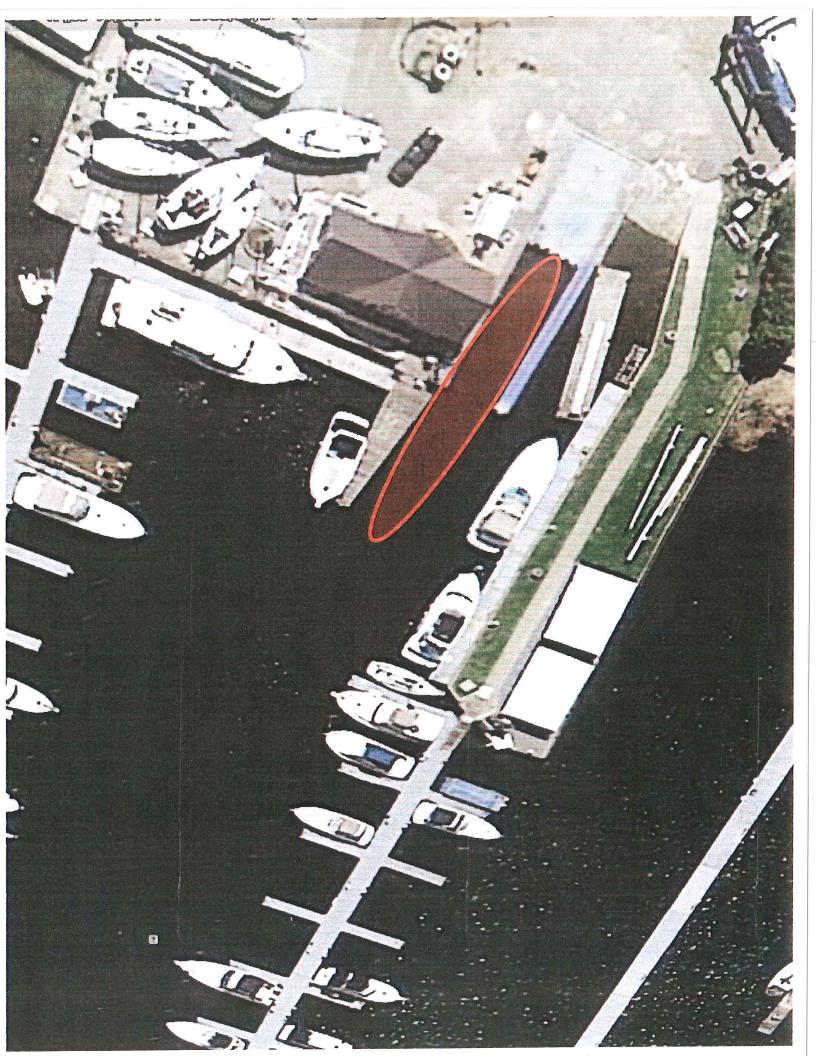

Champlain Marina , Inc. P.O. Box 168 982 West Lakeshore Dr. Colchester, Vermont 05446



10 July, 2016

Dear Michaela Stickney,

Enclosed is our application (copies provided) along with the fees for our proposed dredging permit. I have provided Mike Adams of the A.C.E. their application today. I would appreciate an expedited process to secure this permit. If there is anything I can do to help, don't hesitate to contact me. You have my cell and email address in the e-mails I recently exchanged with you.

Thank you,

Bruce Deming